



NOTES

1. REFER TO DWG E-001 FOR ELECTRICAL SYMBOL LIST, ABBREVIATIONS AND GENERAL NOTES.
2. INTERCEPT AND EXTEND BRANCH CIRCUITS TO PANEL 'SBBR'. PROVIDE BLANK COVER AND PLUG ALL UNUSED OPENINGS.
3. INTERCEPT AND EXTEND BRANCH CIRCUITS TO PANEL 'EB-1'. PROVIDE BLANK COVER AND PLUG ALL UNUSED OPENINGS.
4. INTERCEPT AND EXTEND BRANCH CIRCUITS TO PANEL 'PBMR'. PROVIDE BLANK COVER AND PLUG ALL UNUSED OPENINGS.
5. INTERCEPT AND EXTEND BRANCH CIRCUITS TO PANEL 'LB'.
6. INSTALL NEW INTERIOR AS INDICATED ON THE PANEL SCHEDULE. EXTEND BRANCH WIRES AND TERMINATE IN THE BREAKER AS INDICATED ON THE PANEL SCHEDULE. PROVIDE PANEL COVER WITH UPDATED DIRECTORY.
7. PROVIDE PROFESSIONALLY CORE DRILLED CORES THROUGH EXISTING BUILDING CONCRETE SLAB. CONTRACTOR SHALL SLEEVE AND INSTALL RIGID GALVANIZED CONDUITS TO BUILDING AS REQUIRED.
8. WHERE FEEDERS ARE REQUIRED TO BE ROUTED THROUGH WALLS, CONTRACTOR SHALL MAKE A WALL PENETRATION ABOVE CEILING LEVEL. ALL PENETRATIONS SHALL BE FIRE & SMOKE RATED. PROVIDE HILTI SLEEVE SYSTEM AS REQUIRED FOR ALL WALL PENETRATIONS. REFER TO DETAIL 'E' ON DRAWING E-404.

Exceeding Your Expectations

Lizardos

Mechanical & Electrical Engineering


200 Old Country Road - Mineola - NY 11501
516.484.1020 - Fax 516.484.0926
www.leapc.com

YAS YSRAEL A. SEINUK, P.C.
CONSULTING ENGINEERS
One Woodbridge Center
Woodbridge, New Jersey 07095




Quality Environmental
Solutions & Technology, Inc.

1376 NYS ROUTE 9
WAPPINGERS FALLS, NY 12590
TEL: (845) 298-6031
FAX: (845) 298-6251

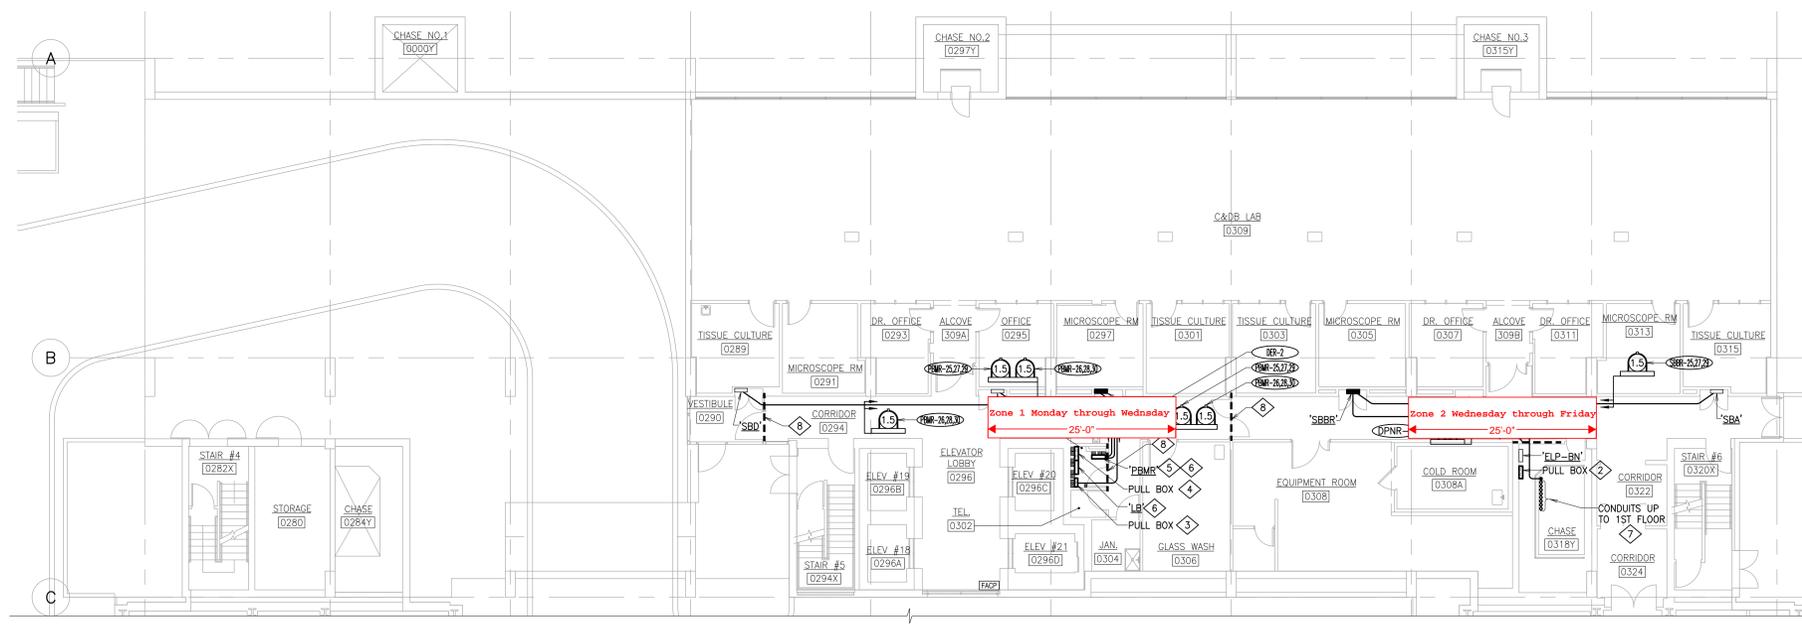

BASEMENT POWER PLAN
SCALE: 1/8" = 1'-0"

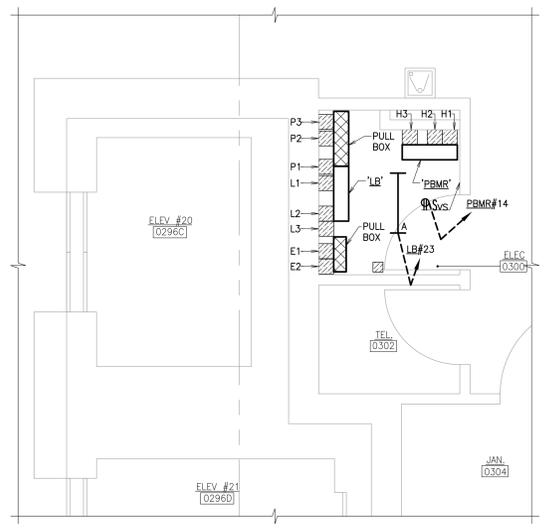

BASEMENT ENLARGED ELECTRICAL CLOSET POWER PLAN
SCALE: 1/2" = 1'-0"

PROJECT: 5105.02 - E-303.dwg DATE: 10/15/24 7:04 PM 1/28/2024 10:50:02 AM 19

NO.	REVISION	DATE
1	POINT SET	01/18/2024
2	100% BD SET	10/09/2023
3	100% BD SET FOR OWNERS REVIEW	06/03/2022
4	ISSUED FOR DESIGN DEVELOPMENT	03/31/2017

STATE UNIVERSITY OF NEW YORK
UPSTATE MEDICAL UNIVERSITY

PROJECT TITLE:
**WEISKOTTEN HALL ADDITION
ELECTRICAL EQUIPMENT
UPGRADES**
SUCF NO. 151006
CAMPUS NO. 685.6/685.7

DRAWING TITLE:
**BASEMENT PART PLAN -
POWER**

DRAWN BY:	VMB	SCALE:	AS NOTED
DESIGNED BY:	YJP	DATE:	06-03-22
CHECKED BY:	MCT	PROJECT NO.:	5105.02
DATE PLOTTED BY:	kzheng	DATE PLOTTED:	10/15/24 7:04 PM
DRAWING NO.:	E-303		
SHEET:	19 of 50		